


## **Neighbouring Consented Schemes**

Former Railway Tavern Site Neighbouring Care Home

Churchill Retirement Living | Planning Issues



HaysomWardMiller Architects	Ground Floor Plan		P03 L
7 Downing Place Cambridge CB2 3EL	Project	Housing Development, Gt Shelford	
T: 01223 578545 F: 01223 351955	For	Great Shelford (Cambridge) LLP	
email : info@haysomwardmiller.co.uk	Scale	1:100 at A1 and 1:200 at A3	

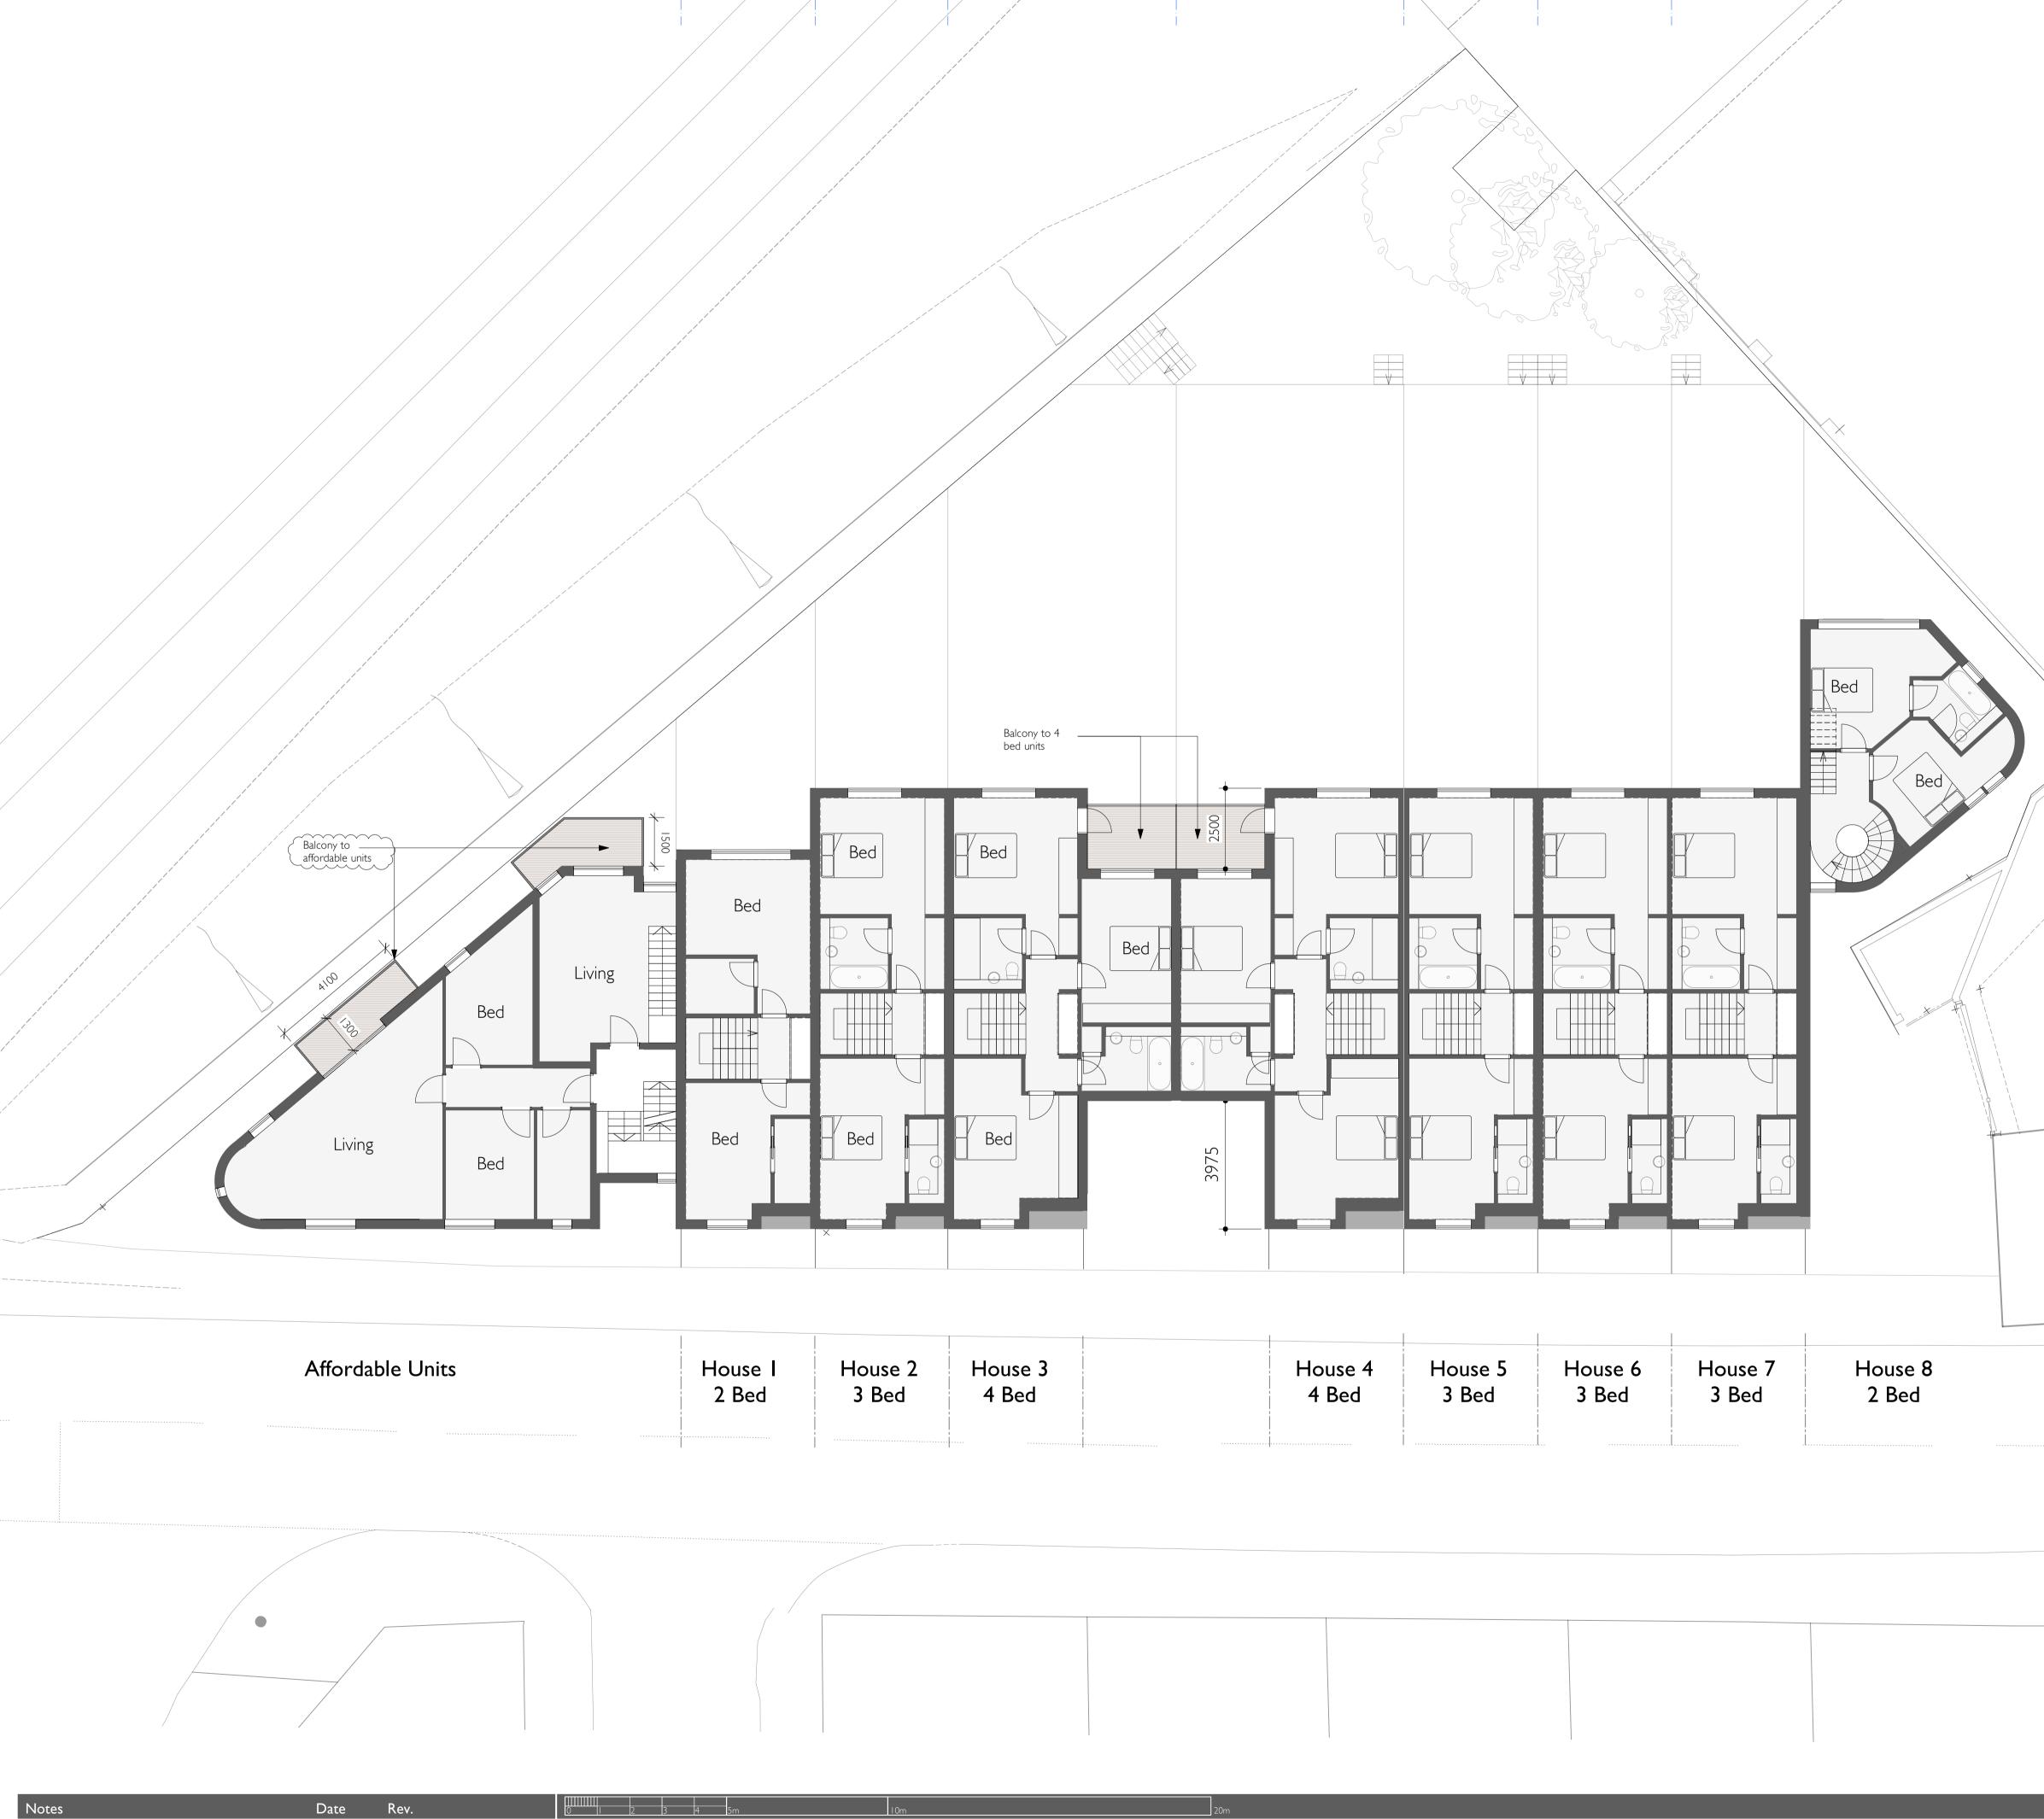

This drawing must not be scaled - work only to figured dimensions
 Dimensions must be verified on site by the contractor before preparation of shop drawings
 The architect must be notified of any discrepancies immediately
 This drawing applies only to this job and site
 This information on this drawing is copyright protected


02.02.2015 I - Planning Application 
 24.04.2015
 J - Client Issue

 30.04.2015
 K - Planning Amendment

1	I	

HaysomWardMiller Architects	Second	Floor Plan	P05	K
7 Downing Place Cambridge CB2 3EL	Project	Housing Development, Gt Shelford		
T: 01223 578545 F: 01223 351955	For	Great Shelford (Cambridge) LLP		
email : info@haysomwardmiller.co.uk	Scale	1:100 at A1 and 1:200 at A3		

 $\sim$ 

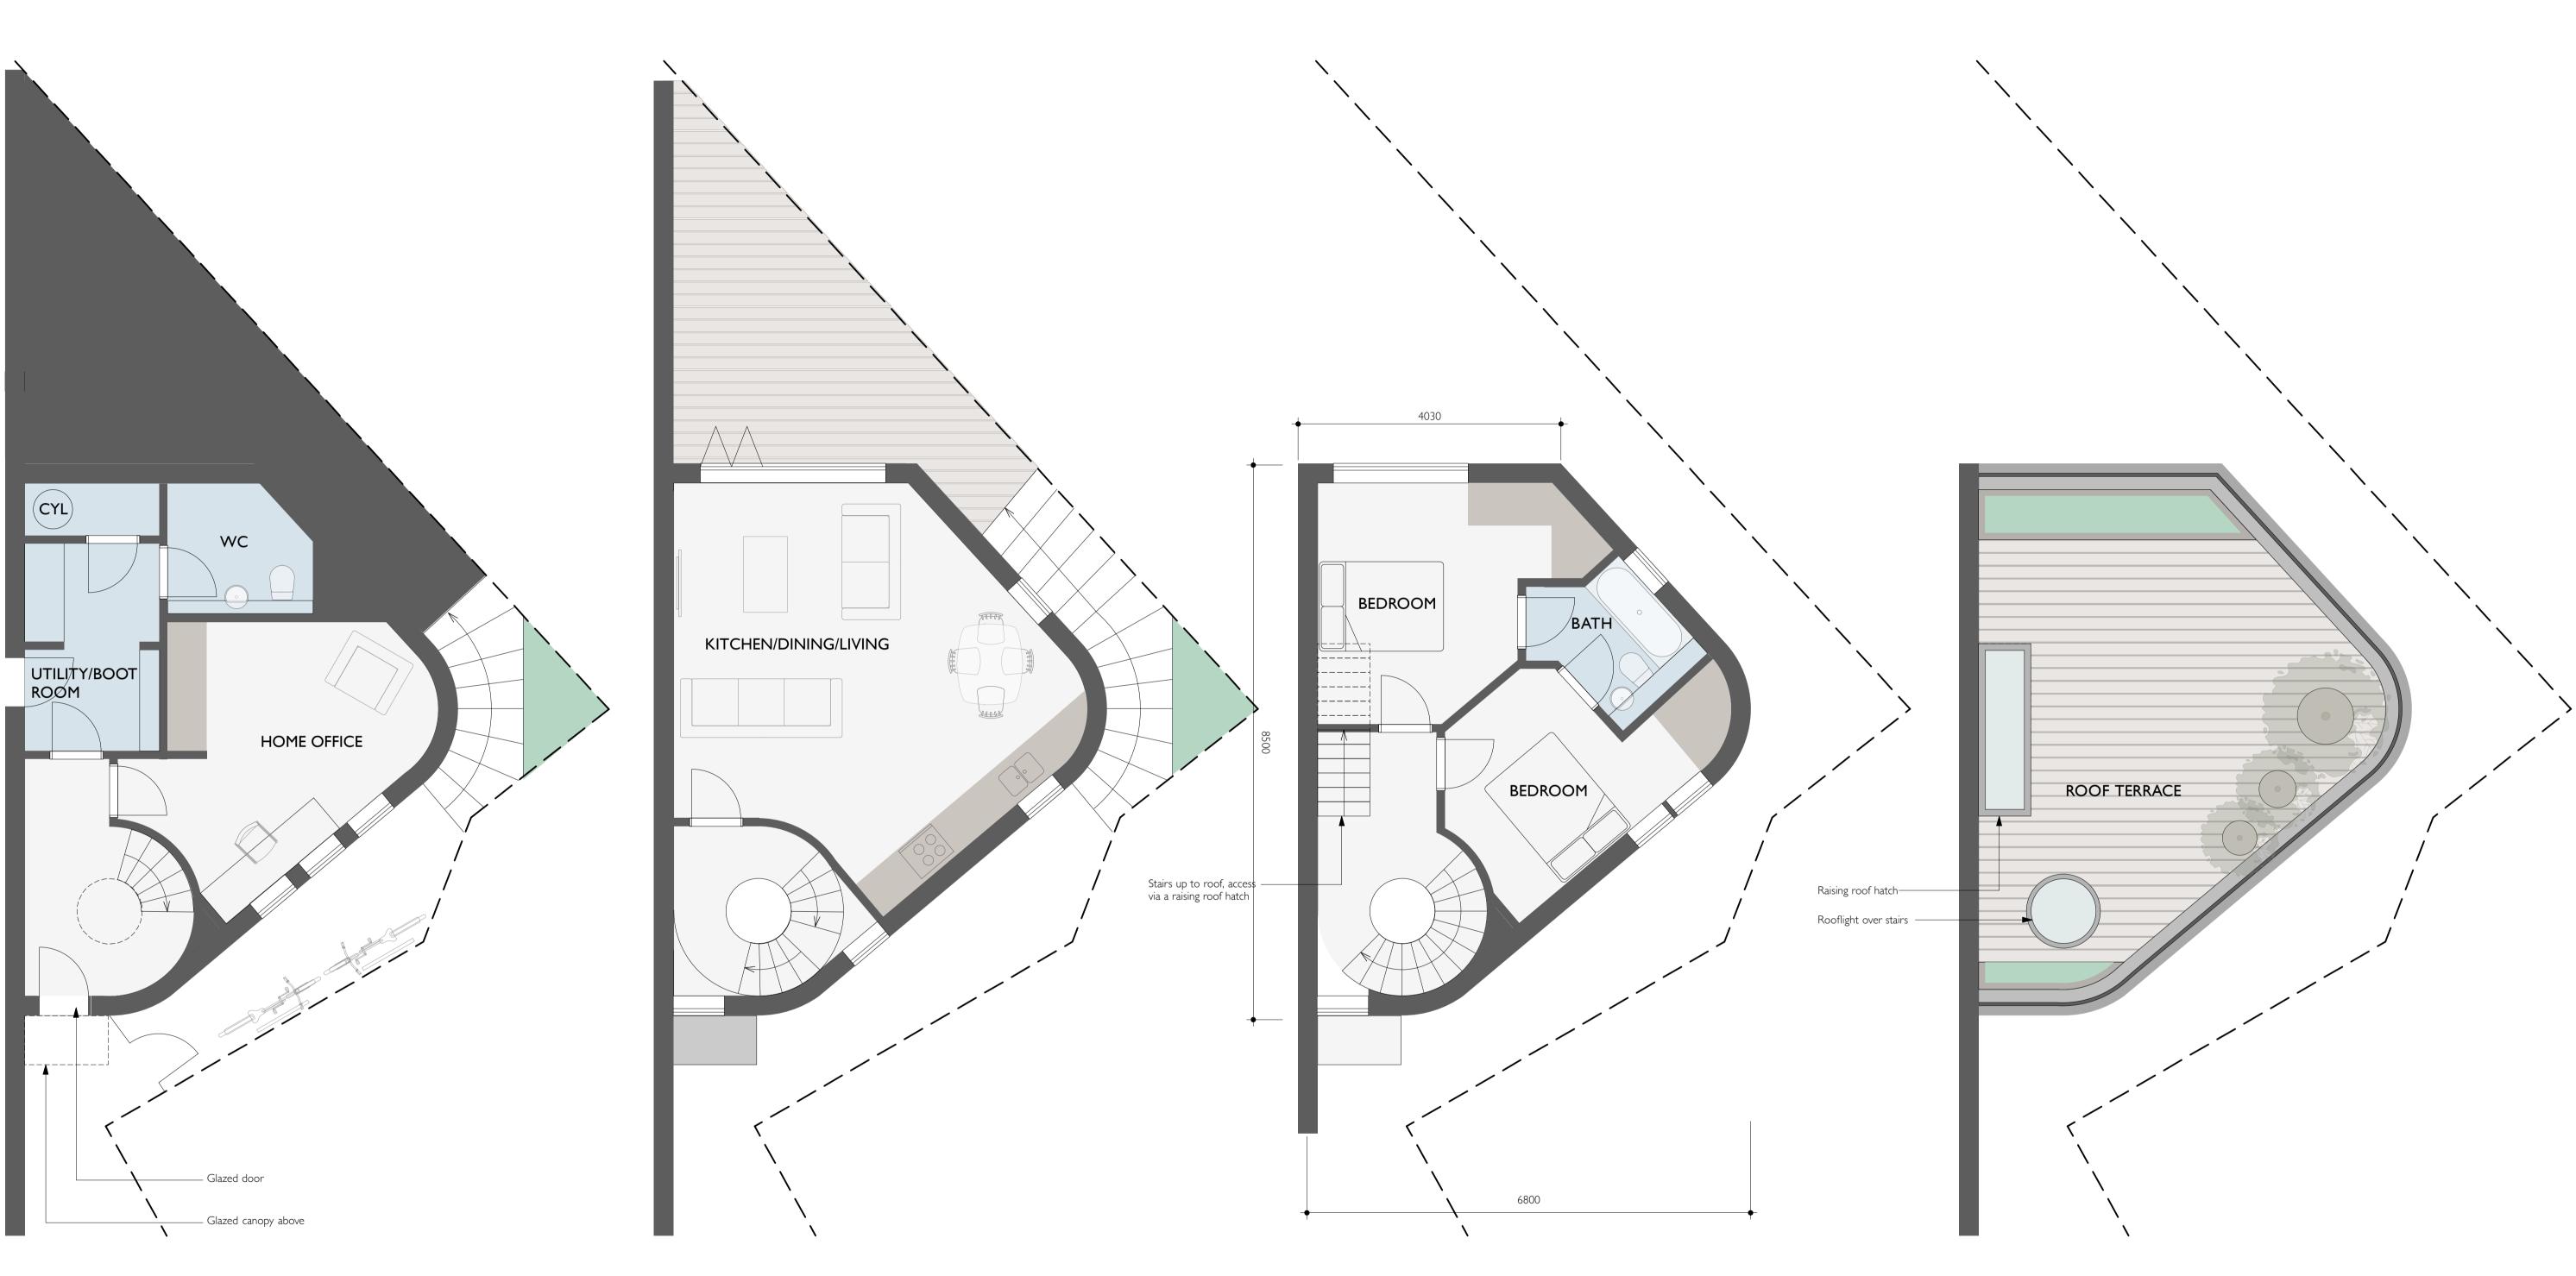

GROUND FLOOR

FIRST FLOOR

Notes		I	Date	Rev.	
0	ot be scaled - work only to figured dimer				
preparation of sho	<ol> <li>Dimensions must be verified on site by the contractor before preparation of shop drawings</li> <li>The architect must be notified of any discrepancies immediately</li> </ol>				
	only to this job and site this drawing is copyright protected	<i>`</i>			

SECOND FLOOR

ROOF

## TOTAL GIA = 109m2

HaysomWardMiller Architects		House 8	PI2 D
7 Downing Place Cambridge CB2 3EL	Project	Housing Development, Gt Shelford	
T: 01223 578545 F: 01223 351955	For	Great Shelford (Cambridge) LLP	
email : info@haysomwardmiller.co.uk	Scale	1:50 at A1 and 1:100 at A3	





Notes	Date	Rev.
<ol> <li>This drawing must not be scaled - work only to figured dimensions</li> <li>Dimensions must be verified on site by the contractor before preparation of shop drawings</li> <li>The architect must be notified of any discrepancies immediately</li> <li>This drawing applies only to this job and site</li> <li>This information on this drawing is copyright protected</li> </ol>		

HaysomWardMiller Architects	Typical 3 Bed House		PI0 H
7 Downing Place Cambridge CB2 3EL	Project	Housing Development, Gt Shelford	
T: 01223 578545 F: 01223 351955	For	Great Shelford (Cambridge) LLP	
email : info@haysomwardmiller.co.uk	Scale	1:50 at A1 and 1:100 at A3	



HaysomWardMiller Architects	
7 Downing Place Cambridge CB2 3EL	
T: 01223 578545 F: 01223 351955	



PROPOSED BOUNDARY PLAN

#### $\bigcirc$ notes

$\cup$	I TO I LO		
© O	hot be reproduced in any way without their specific permission All dimensions are to be checked on site. Do not scale from thi		
KEY			
	_	1.8m close boarded timber fence height varies to suit location	
	-	1.2m high hoop topped railings	
_	-	1.8m high hoop topped railings	
	-	Masonry boundary wall, 1.8m min - Existing to be retained where possible	

#### PLANNING SUBMISSION

С	Site plan updated, railings updated	11.10.2021	SC
В	Northern boundary line updated to match site plan drawing	18.05.2020	SC
А	Building footprint and landscaping revised	07.05.2020	SC
*	Planning Issue	16.08.19	MP
	REVISION DETAILS	date / na	me
•	Preliminary		
0	For Approval		
$\bigcirc$	Tender		
$\bigcirc$	Construction		
	CLIENT		
	Porthaven		
	2 Station Road		
	Great Shelford		
	DRAWING TITLE		
Вс	oundary Plan		
	SCALE drawn by	da	
	1:500 @A3 SC	25.06.	
	DRAWING NO.	revision	
	10 100 115	$\bigcirc$	
	18-182-115	U	
	<u></u>		
	6	=7	Υ.
	10040/11/00	00 = Ar 110 s	10 -
T:	0151 207 4371 • <b>F:</b> 0	151 207 7	087
_			



### 

- C This drawing is copyright of Condy and Lofthouse Ltd. and may not be reproduced in any way without their specific permission.
- All dimensions are to be checked on site. Do not scale from this drawing, work to figured dimensions only. Any queries please contact the architects. NOTES

- Scheme subject to further detailed design and Statutory Approvals
   All levels taken from topographical survey information as provided by Survey Solutions dwg No 24/05/2019.
   Ground floor FFL +18.700 as proposed.
- 4. Tree locations taken from topographical
- survey information as provided by Survey Solutions dwg No 24/05/2019
  Root protection areas as taken from Arboricultural proposed site plan drawing number P1205-ASP02 by Ligna Consultancy
- KEY Site Boundary \_ Existing Buildings Proposed Care Home Paths and Hard Landscaping Amenity Terrace Pedestrian Paving Vehicular Access Area Parking Bays Grass and Soft Landscaping m
- Hedge 1.8m close boarded timber fence 1.2m railing \_ - -СН Cycle Hoops  $\langle \rangle$ Site Entrance Building Entrances Pleached Trees

Vehicle Barrier \_ \_ Retaining Wall


### SCHEDULE OF ACCOMMODATION

- 63 Bed Care Home
- (21 per floor)
- 26No Car Parking Spaces

### PLANNING SUBMISSION

\* First Issue 07.10.2021 REVISION DETAILS date / name  $\bigcirc$  Preliminary For Approval  $\bigcirc$  Tender  $\bigcirc$  Construction CLIENT Porthaven 2 Station Road Great Shelford DRAWING 1111 Proposed Site Plan SCALE drawn by date 1:200 @A1 SC 10/07/21 DRAWING NO. revision \* 18-182-310

contribution of a filled

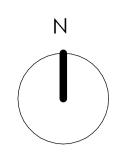



### ○ NOTES

Ν

- C This drawing is copyright of Condy and Lofthouse Ltd. and may not be reproduced in any way without their specific permission. All dimensions are to be checked on site. Do not scale from this drawing, work to figured dimensions only. Any queries please contact the architects.

#### ○ MATERIALS PROHIBITED

- Materials prohibited from use, except where used in accordance with 'Good Practice in the Selection of Construction Materials (March 2011)' or unless required by the Contract:
- c) d)
- e)
- f)
- Materials prohibited from use, except where used in accordance with 'Good Practice in the Selection of Construction Materials (March 2011)' or unless required by the Contract: high alumina cement in the structural elements; wood wool slabs in permanent formwork to concrete; calcium chloride admixtures for use in reinforced concrete; calcium chloride admixtures for use in reinforced concrete; calcium chloride admixtures for one of the concrete; calcium chloride admixtures for one of the concrete; calcium chloride admixtures for use in reinforced concrete; calcium chloride admixtures for one of the concrete, cancer the thereof; any naturally occurring or man made mineral fibres (for example, rock-wool or slag wool) with a thickness of 3 microns or less and a length of 200 microns or less, unless they are appropriately sealed to prevent migration of fibres; aggregates for use in reinforced concrete which do not comply with: "B EN 13139'2002; Properties of aggregates used in concrete. "B EN 13139'2002; Properties of aggregates used in mortar. "B EN 13139'2002; Properties of aggregates used in mortar. "B EN 1305' (Parts 1 & 2') properties of lightweight aggregates. "Guidance on avoiding alkali-silica reaction and limitations on alkali content in BRE Digest 330 (2004)' & 'Concrete Society Technical Report 30 (1999)'; lead, lead paint or any other materials containing lead whork may be ingested, inholed or absorbed, except where copper alloy filtings also containing lead are specifically required in drinking water pipewark by any relevant statutory requirement or where lead flashings or other lead roof coverings are specifically provided for in the Contract; calcium silicate bricks or tile; verniculite unless it is established as being fibre-free; calcium si g)
- h)

- m) n)
- to erosion; concrete used in circumstances where it is susceptible to alkali/silica reaction; materials containing chlorofluorocarbons (CFCs); solvent based paints except where water based paints are unsuitable for unavailable; any new materials not in accordance with statutory requirements, Birlish Standards, Codes of Practice and good building practice current at the date of incorporation of the relevant materials into the Works or the specifications thereof;

#### NOTES


- 1. Scheme is subject to further detailed design and relevant Statutory Approvals.
- 2. Scheme is based on topographical survey by Survey Solutions drawing no. 24396ea-01 24/05/2019.

#### ACCOMODATION

	BEDS	GIA (m²	2)
Ground Floor	21	1237	
First Floor	21	1245	
Second Floor	21	1016	
TOTAL	63	3498	(55.5m²/Bed)

Dummy window

## FIRST FLOOR PLAN - PROPOSED

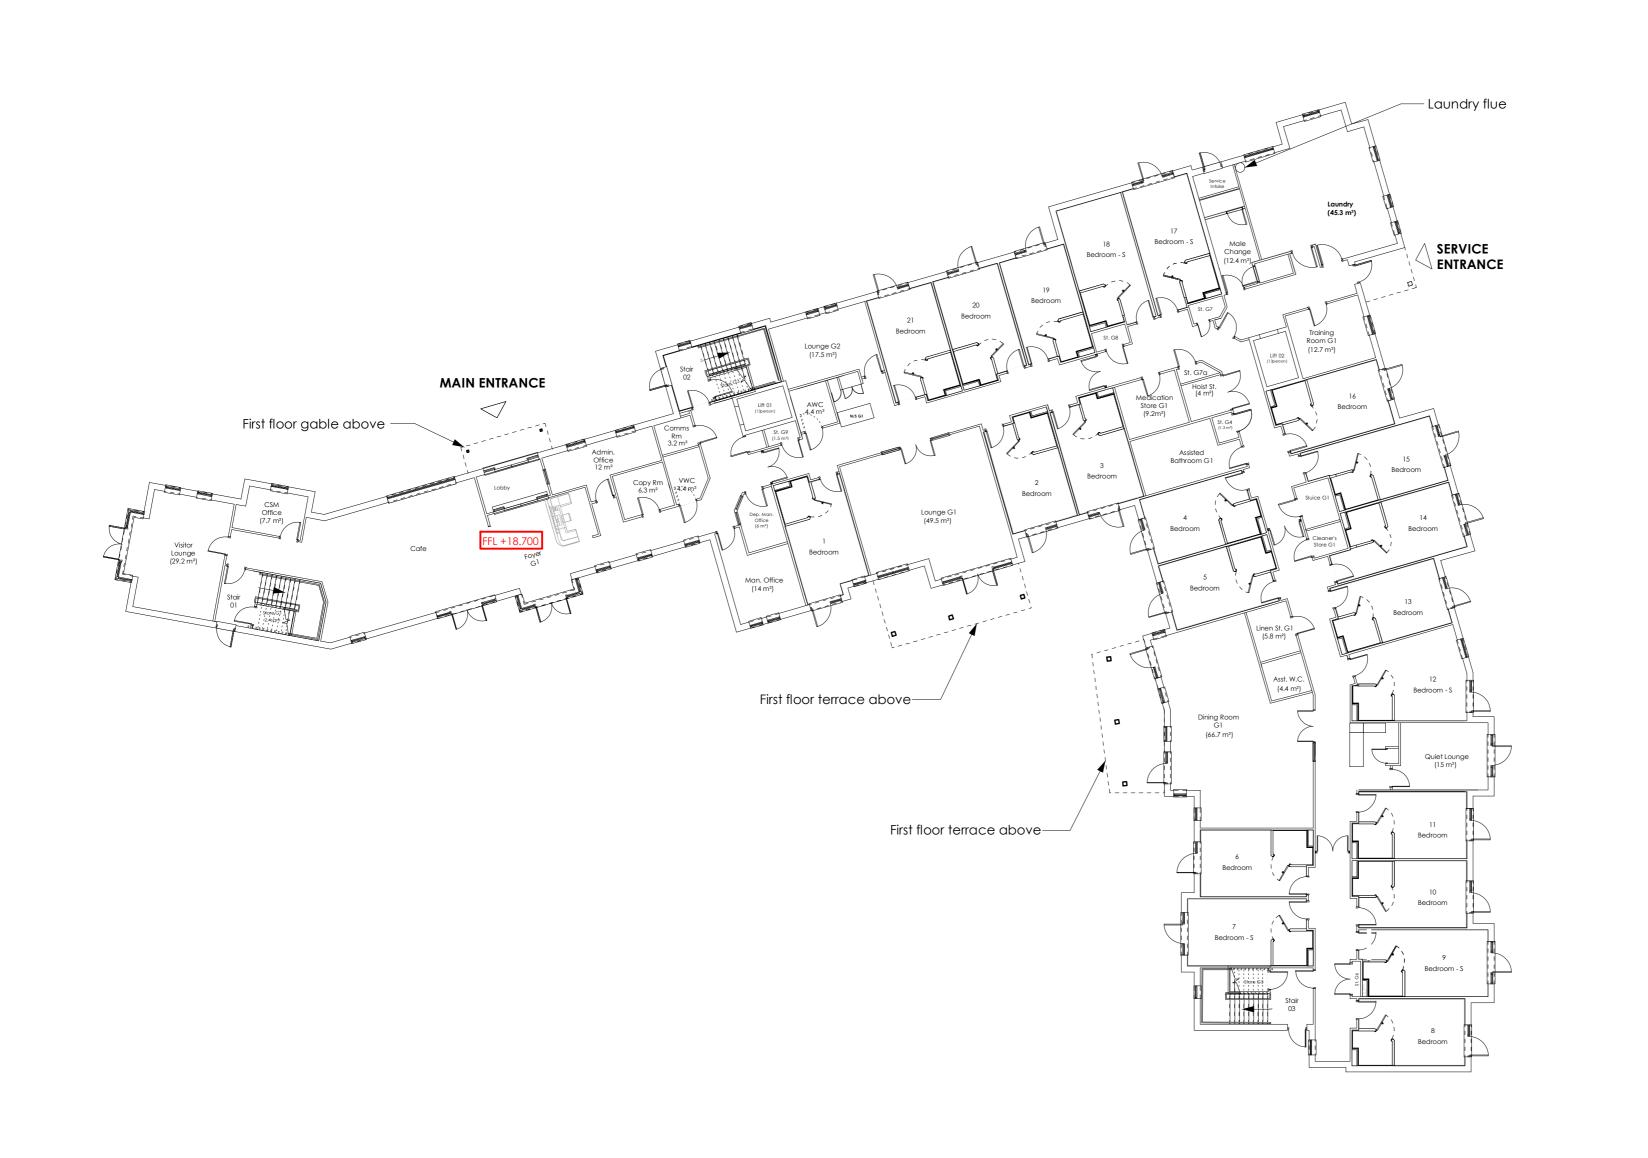

D Drawing amended to 04.10.2021 suit Client update GWP requirements, refer to Planning Consultant information.

#### PLANNING SUBMISSION

С	Amendments to respond to Planning Officer's concerns: 1. Quiet Lounge omitted and replaced with Bedroom 21. 2. Lounge/Dining 2 increased. 3. Bedrooms 4 & 5 relocated from south end of building to increase interface distance to neighbouring property. 4. Staff area reconfigured and building foot print amended to accommodate. 5. GIA updated to suit.	12.05.2020 MP
В	GIA reduced and schedule updated.	19.03.2020 MP
	Bedrooms 12 & 17 on each floor, reduced from superior bedrooms to standard bedroom to enable amendments to	
	Bay to the 2 storey western elevation gable amended to glazing/aluminium. Balcony access /	

balustrading omitted.

Bay above main entrance, at 1st floor, amended to curtain wall

Bay at ground floor adjacent to main

entrance omitted and

glazing.

24 Derby Road 🖓 Liverpool 🎖 L5 9PR 🎖 E: info@condylofthouse.co.uk 🥇 www.condylofthouse.co.uk

ĉ,

nect Busir

Co

17,

Unit

 $\mathbf{N}$ CLA

as

 $\Box$ 

Ę

∞

Ũ

## **GROUND FLOOR PLAN** - PROPOSED

1 0 1 2 3 4 5 metres

**T:** 0151 207 4371 ? **F:** 0151 207 7087

# - Laundry flue - Plant flues Second floor dormer A Car - Kitchen flues 00 \_\_\_\_ ----' Flat roof Flat roof Second floor dormer , \_|\_ , .\_\_. Flat roof

### ○ NOTES

Ν

- C This drawing is copyright of Condy and Lofthouse Ltd. and may not be reproduced in any way without their specific permission. All dimensions are to be checked on site. Do not scale from this drawing, work to figured dimensions only. Any queries please contact the architects.

#### ○ MATERIALS PROHIBITED

- Materials prohibited from use, except where used in accordance with 'Good Practice in the Selection of Construction Materials (March 2011)' or unless required by the Contract:
- a) b) c) d)
- e)
- f)
- Materials prohibited from use, except where used in accordance with 'Good Practice in the Selection of Construction Materials (March 2011)' or unless required by the Contract: high alumina cement in the structural elements; wood wool slobs in permanent formwork to concrete; calcium chloride admixtures for use in reinforced concrete; cabestos or asbestos-containing products, as defined in the 'Control of Asbestos at Work Regulations, as amended 2006' or any other statutory modification or re-enactment thereof; any naturally occurring or man made mineral fibres (for example, rock-wool or slag wool) with a thickness of 3 microns or less and a length of 200 microns or less, unless they are appropriately sealed to prevent migration of fibres; aggregates for use in reinforced concrete which do not comply with: "BS EN 136202002; properties of aggregates used in concrete. "BS EN 13052(Pars 1 & 2); properties of algregation and limitations on alkali content in BRE Digest 330 (2004) & 'Concrete Society Technical Report 30 (1999); lead, lead paint or any other materials containing lead which may be ingested, inhaled or absorbed, except where copper alloy filtings also containing lead are specifically required in drinking water pipework by any relevant statutory requirement or where lead flashings or other lead roof coverings are specifically provided for in the Contract; urea formaldehyde foam or materials which may release formaldehyde in quantities which may be hazardous with reference to the limits set by the Health and Safety Executive; calcium silicate bricks or file; vermiculite unless it is established as being fibre-free; calcium silicate bricks or files; any products containing cadmium referred to in Statutory Instrument 'SI 2006/3311 Controls on dangerous substances and preparations Regulations 2006'. Reference should also be made to htsE IDEGS191 Cadmium and you; any new fimber treated with pentachlorophenol; non galvanised mild steel structural fixings for building elements particularly susceptible to erasion g)
- h)
- l) m)
- n) o)
- to erosion; concrete used in circumstances where it is susceptible to alkali/silica reaction; materials containing chlorofluorocarbons (CFC's); solvent based paints except where water based paints are unsuitable for unavailable; any new materials not in accordance with statutory requirements, British Standards, Codes of Practice and good building practice current at the date of incorporation of the relevant materials into the Works or the specifications thereof; p) q)

#### NOTES

- 1. Scheme is subject to further detailed design and relevant Statutory Approvals.
- 2. Scheme is based on topographical survey by Survey Solutions drawing no. 24396ea-01 24/05/2019.


#### KEY

Access hatch to roof

Access hatch to roof



## **ROOF PLAN** - PROPOSED

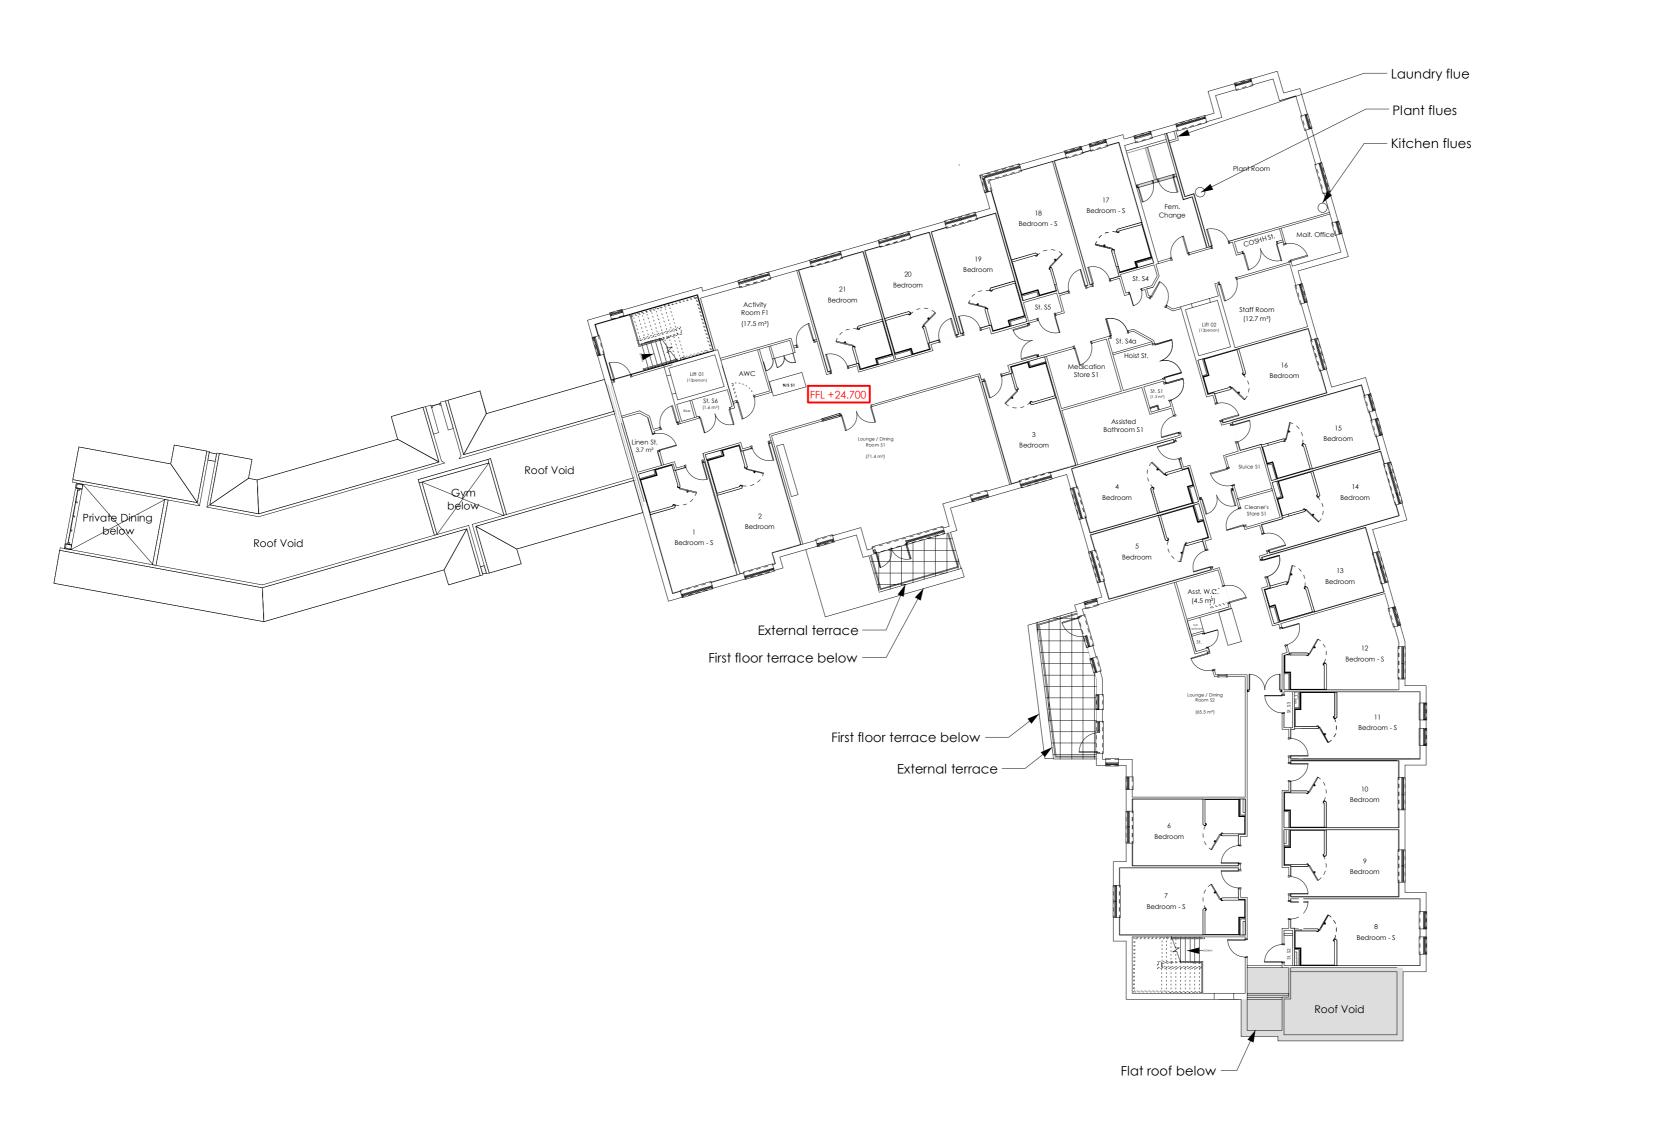

2. Bedrooms 4 & 5

relocated from south end of building to increase interface distance to

neighbouring property. 3. Staff area reconfigured

and building foot print

amended to

accommodate.

ge

Villa

Busi

lect

Co

17,

Unit

as

ວ

Ę

∞



## SECOND FLOOR PLAN - PROPOSED

1 0 1 2 3 4 5 metres




## **01 NORTH ELEVATION**



## **02 EAST ELEVATION**



## **03 SOUTH GABLE ELEVATION**

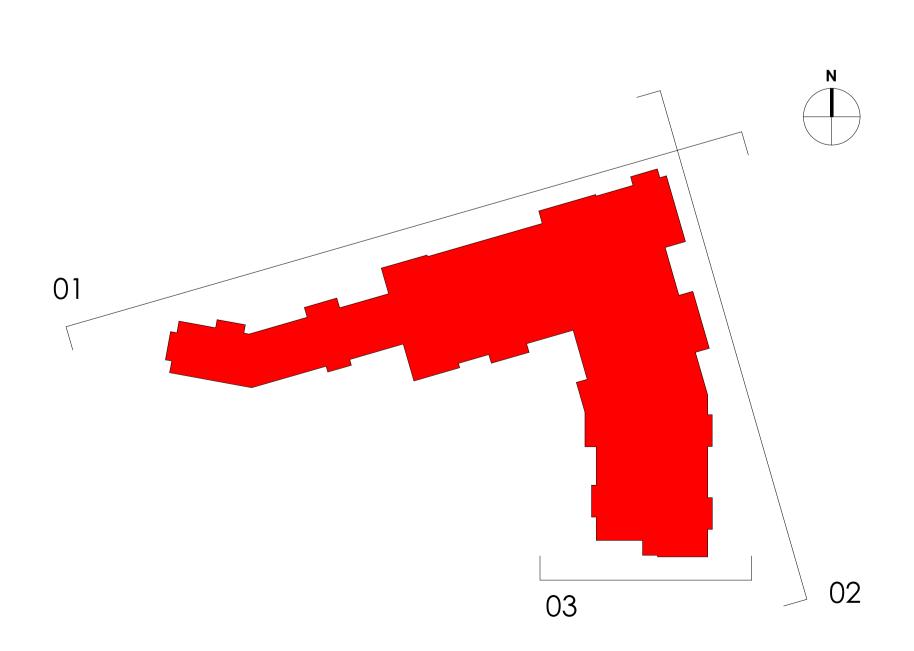

KEY PLAN - SCALE 1:500

- $\bigcirc$  NOTES
- $\bigcirc$  This drawing is copyright of Condy and Lofthouse Ltd. and may not be reproduced in any way without their specific permission.
- All dimensions are to be checked on site. Do not scale from this drawing, work to figured dimensions only. Any queries please contact the architects.

### ○ MATERIALS PROHIBITED

- Materials prohibited from use, except where used in accordance with 'Good Practice in the Selection of Construction Materials (March 2011)' or unless required by the Contract:
- a) high alumina cement in the structural elements;
   b) wood wool slabs in permanent formwork to concrete;
   c) calcium chloride admixtures for use in reinforced concrete;
- c) calcium chloride admixtures for use in reinforced concrete;
  d) asbestos or asbestos-containing products, as defined in the 'Control of Asbestos at Work Regulations, as amended 2006' or any other statutory modification or re-enactment thereof;
  e) any naturally occurring or man made mineral fibres (for example, rock-wool or slag wool) with a thickness of 3 microns or less and a length of 200 microns or less, unless they are appropriately sealed to prevent migration of fibres;
  f) aggregates for use in reinforced concrete which do not comply with:
  "BS EN 12620:2002: properties of aggregates used in concrete.
  "BS EN 13055 (Parts 1 & 2): properties of tightweight aggregates.
  "Guidance on avoiding alkali-silica reaction and limitations on alkali content in BRE Digest 330 (2004)' & 'Concrete Society Technical Report 30 (1999)';
  g) lead, lead paint or any other materials containing lead which may be ingested, inhaled or absorbed, except where copper alloy fittings also containing lead are specifically required in drinking water pipework by any relevant statutory requirement or where lead flashings or other lead roof coverings are specifically provided for in the Contract;

- Contract; b) urea formaldehyde foam or materials which may release formaldehyde in quantitie: which may be hazardous with reference to the limits set by the Health and Safety Executive;
- i) calcium silicate bricks or tiles; i) verniculte unless it is established as being fibre-free; calcium silicate bricks or tiles;
   k) any products containing cadmium referred to in Statutory Instrument 'SI 2006/3311 Controls on dangerous substances and preparations Regulations 2006'. Reference
- should also be made to 'HSE IDGE391 Cadmium and you'; any new timber treated with pentachlorophenol;
   m) non galvanised mild steel structural fixings for building elements particularly susceptibl
- to erosion; n) concrete used in circumstances where it is susceptible to alkali/silica reaction;
- n) concrete used in circumstances where it is susceptible to akalifylica reaction;
   o) materials containing chloraflorrocarbons (CFC's);
   p) solvent based paints except where water based paints are unsuitable for unavailable;
   q) any new materials not in accordance with statutory requirements, British Standards,
   Cades of Practice and good building practice current at the date of incorporation of the relevant materials into the Works or the specifications thereof;

## NOTES

- 1. Scheme is subject to further detailed design and relevant Statutory Approvals.
- 2. Scheme is based on topographical survey by Survey Solutions drawing no. 24396ea-01 24/05/2019.
- 3. All materials and finishes to be approved by the local Planning Authority.
- 4. All bedroom en-suites and inner rooms to be ventilated by mechanical extract grille (wall and roof mounted). Grilles to be colour matched to external finishes. Locations TBC.
- 5. Services and plant flues indicative and subject to specialist design.

### **KEY MATERIALS**

Facing brick - buff Horizontal cladding - grey Roof tiles - grey Flashing - grey Fascia board - white

E

1-+--

Rainwater goods - grey



 $\bigcirc$  Tender  $\bigcirc$  Construction CLIENT Porthaven PROJECT 2 Station Road Great Shelford DRAWING TITLE Elevations - Proposed - Sheet 1 SCALE 1:100 @A1 SC 10/07/21 DRAWING NO. revision 18-182-350

\* First Issue

 $\bigcirc$  Preliminary

For Approval

T: 0151 207 4371 • F: 0151 207 7087

contribution of Artifity



## **01 WEST SECTIONAL ELEVATION**




# **02 SOUTH SECTIONAL ELEVATION**



## **03 WEST GABLE ELEVATION**

## **KEY MATERIALS**



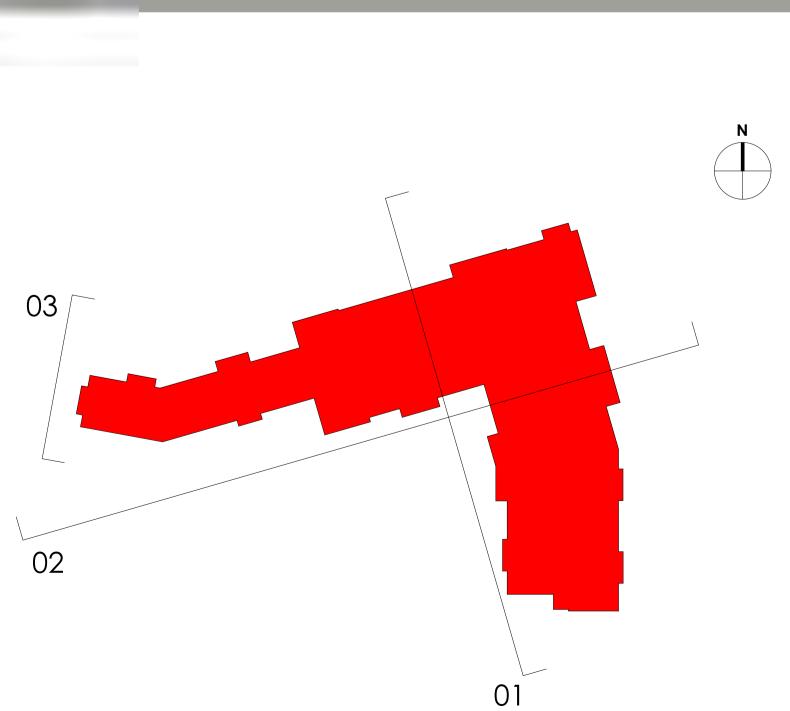

### $\bigcirc$ NOTES

- $\bigcirc$  This drawing is copyright of Condy and Lofthouse Ltd. and may not be reproduced in any way without their specific permission.
- All dimensions are to be checked on site. Do not scale from this drawing, work to figured dimensions only. Any queries please contact the architects.

### ○ MATERIALS PROHIBITED

Materials prohibited from use, except where used in accordance with 'Good Practice in the Selection of Construction Materials (March 2011)' or unless required by the Contract:

- The selection of Construction Materials (March 2011)' or unless required by the Contract:
  a) high alumina cement in the structural elements;
  b) wood wool slabs in permanent formwork to concrete;
  c) calcium chloride admixtures for use in reinforced concrete;
  d) asbestos or asbestos-containing products, as defined in the 'Control of Asbestos at Work Regulations, as amended 2006' or any other statutory modification or re-enactment thereof;
  e) any naturally occurring or man made mineral fibres (for example, rock-wool or slag wool) with a thickness of 3 microns or less and a length of 200 microns or less, unless they are appropriately sedled to prevent migration of fibres;
  f) aggregates for use in reinforced concrete which do not comply with:
  BS EN 12620:2002; properties of aggregates used in concrete.
  'BS EN 13055 (Parts 1 & 2): properties of lightweight aggregates.
  'Guidance on avoiding alkali-silica reaction and limitations on alkali content in BRE Digest 300 (2004)' & 'Concrete Society Technical Report 30 (1999)';
  g) lead, lead paint or any other materials containing lead which may be ingested, inhaled or absorbed, except where copper alloy fittings also containing lead are specifically required in drinking water pipework by any relevant statutory requirement or where lead flashings or other lead root coverings are specifically provided for in the Contract;

- Contract;

- of where lead itestings of other lead foor coverings are specifically provided for in the Contract;
  h) urea formaldehyde foam or materials which may release formaldehyde in quantities which may be hazardous with reference to the limits set by the Health and Safety Executive;
  i) calcium silicate bricks or tiles;
  j) vermiculite unless it is established as being fibre-free; calcium silicate bricks or tiles;
  k) any products containing cadmium referred to in Statutory Instrument'SI 2006/3311
  Controls on dangerous substances and preparations Regulations 2006'. Reference should also be made to 'HSE IDGE391 Cadmium and you';
  i) any new timber treated with pentachlorophenol;
  m) non galvanised mild steel structural fixings for building elements particularly susceptible to erosion;
  o) materials containing chlorofluorocarbons (CFC's);
  p) solvent based paints except where water based paints are unsuitable for unavailable;
  q) any new materials not in accordance with statutory requirements, British Standards, Codes of Practice and good building practice current at the date of incorporation of the relevant materials into the Works or the specifications thereof;

### NOTES

03 Second Floor Plan \_\_\_\_247<u>00</u>

01 First Floor Plan \_\_\_\_217<u>00</u> 🔽

00 Ground Floor Plan

18700

- 1. Scheme is subject to further detailed design and relevant Statutory Approvals.
- 2. Scheme is based on topographical survey by Survey Solutions drawing no. 24396ea-01 24/05/2019.
- 3. All materials and finishes to be approved by the local Planning Authority.
- All bedroom en-suites and inner rooms to be ventilated by mechanical extract grille (wall and roof mounted). Grilles to be colour matched to external finishes. Locations TBC.
- 5. Services and plant flues indicative and subject to specialist design.

### PLANNING SUBMISSION

* First lague	
FIRST ISSUE	07.10.2021 SC
	S date / name
O Preliminary	
For Approval	
$\bigcirc$ Tender	
$\bigcirc$ Construction	
CLIENT	
Porthaven	
2 Station Road	
Great Shelford	
DRAWING TITLE	
Unnamed	
SCALE	drawn by date
1:100 @A1	Author 10/07/21
DRAWING NO.	revision
18-182-351	*
	A 100
	-15

